

LOCATION MAP
1"=3000'

WETLAND NOTES

THE LIMITS OF JURISDICTIONAL WETLANDS AS SHOWN ON THIS PLAN WERE DELINEATED BY GOVE ENVIRONMENTAL SERVICES, INC., IN ACCORDANCE WITH:

1. US ARMY CORPS OF ENGINEERS REGIONAL SUPPLEMENT TO THE CORPS OF ENGINEERS WETLAND DELINEATION MANUAL: NORTH-CENTRAL AND NORTHEAST REGION, TECHNICAL REPORT ERDC/EL TR-12-1, JANUARY 2012, VERSION 2.0
2. FIELD INDICATORS OF HYDRIC SOILS IN THE UNITED STATES, A GUIDE FOR IDENTIFYING AND DELINEATING HYDRIC SOILS, VERSION 7.0, UNITED STATES DEPARTMENT OF AGRICULTURE (2010).
3. NORTH AMERICAN DIGITAL FLORA: NATIONAL WETLAND PLANT LIST, VERSION 2.2.1 (2009).

NOTES

1. UNDERGROUND FACILITIES, UTILITIES AND STRUCTURES HAVE BEEN LOCATED FROM FIELD OBSERVATIONS AND THEIR LOCATIONS MUST BE CONSIDERED APPROXIMATE ONLY. BEALS ASSOCIATES OR ANY OF THEIR EMPLOYEES TAKE NO RESPONSIBILITY FOR THE LOCATION OF ANY UNDERGROUND STRUCTURES OR UTILITIES NOT SHOWN, THAT MAY EXIST. IT IS THE RESPONSIBILITY OF THE CONTRACTOR TO HAVE ALL UNDERGROUND UTILITIES OR STRUCTURES LOCATED PRIOR TO EXCAVATION WORK BY CALLING 1-888-DIG-SAFE
2. THIS PLAN HAS BEEN PREPARED FOR MUNICIPAL AND STATE APPROVALS AND FOR CONSTRUCTION BASED ON DATA OBTAINED FROM ON-SITE FIELD SURVEY AND EXISTING MUNICIPAL RECORDS. THROUGHOUT THE CONSTRUCTION PROCESS, THE CONTRACTOR SHALL INFORM THE ENGINEER IMMEDIATELY OF ANY FIELD DISCREPANCY FROM DATA AS SHOWN ON THE DESIGN PLANS. THIS INCLUDES ANY UNFORESEEN CONDITIONS, SUBSURFACE OR OTHERWISE, FOR EVALUATION AND RECOMMENDATIONS. ANY CONTRADICTION BETWEEN ITEMS OF THIS PLAN/PLAN SET, OR BETWEEN THE PLANS AND ON-SITE CONDITIONS MUST BE RESOLVED BEFORE RELATED CONSTRUCTION HAS BEEN INITIATED.
3. ALL BENCHMARKS AND TOPOGRAPHY SHOULD BE FIELD VERIFIED BY THE CONTRACTOR.
4. ALL DRAINAGE WORK TO CONFORM TO TOWN STANDARD SPECIFICATIONS FOR CONSTRUCTION.
5. ALL PROPOSED SIGNS SHALL CONFORM TO THE TOWN ZONING REGULATIONS.
6. PROJECT IS BASED ON USGS DATUM NAVD 1988. REFERENCE
7. THE LANDOWNER IS RESPONSIBLE FOR COMPLYING WITH ALL APPLICABLE LOCAL, STATE AND FEDERAL WETLAND REGULATIONS, INCLUDING ANY PERMITTING AND SETBACK REQUIREMENTS REQUIRED UNDER THESE REGULATIONS.
8. DISTURBANCE IS UNDER 100,000 SQ. FT. ALTERATION OF TERRAIN PERMIT RSA 485-A-17 IS NOT REQUIRED.
9. ALL NEW HOUSES TO BE EQUIPPED WITH STONE DRIP EDGES TO COLLECT ROOF RUNOFF (SEE DETAIL).
10. ALL NEW DRIVEWAYS TO HAVE BIORETENTION (DRY) SWALES ON THE LOW SIDE (SEE DETAILS).

ZONING REQUIREMENTS

ZONE: RESIDENTIAL/AGRICULTURAL-(RA)
MIN. LOT SIZE = 2 ACRES
MIN. FRONTAGE = 200'
MAX. HEIGHT = 34'
MIN. OPEN SPACE = 60%

BUILDING SETBACKS:
FRONT 50'
SIDE & REAR 50'
POORLY DRAINED SOILS 50'
VERY POORLY DRAINED SOILS 75'

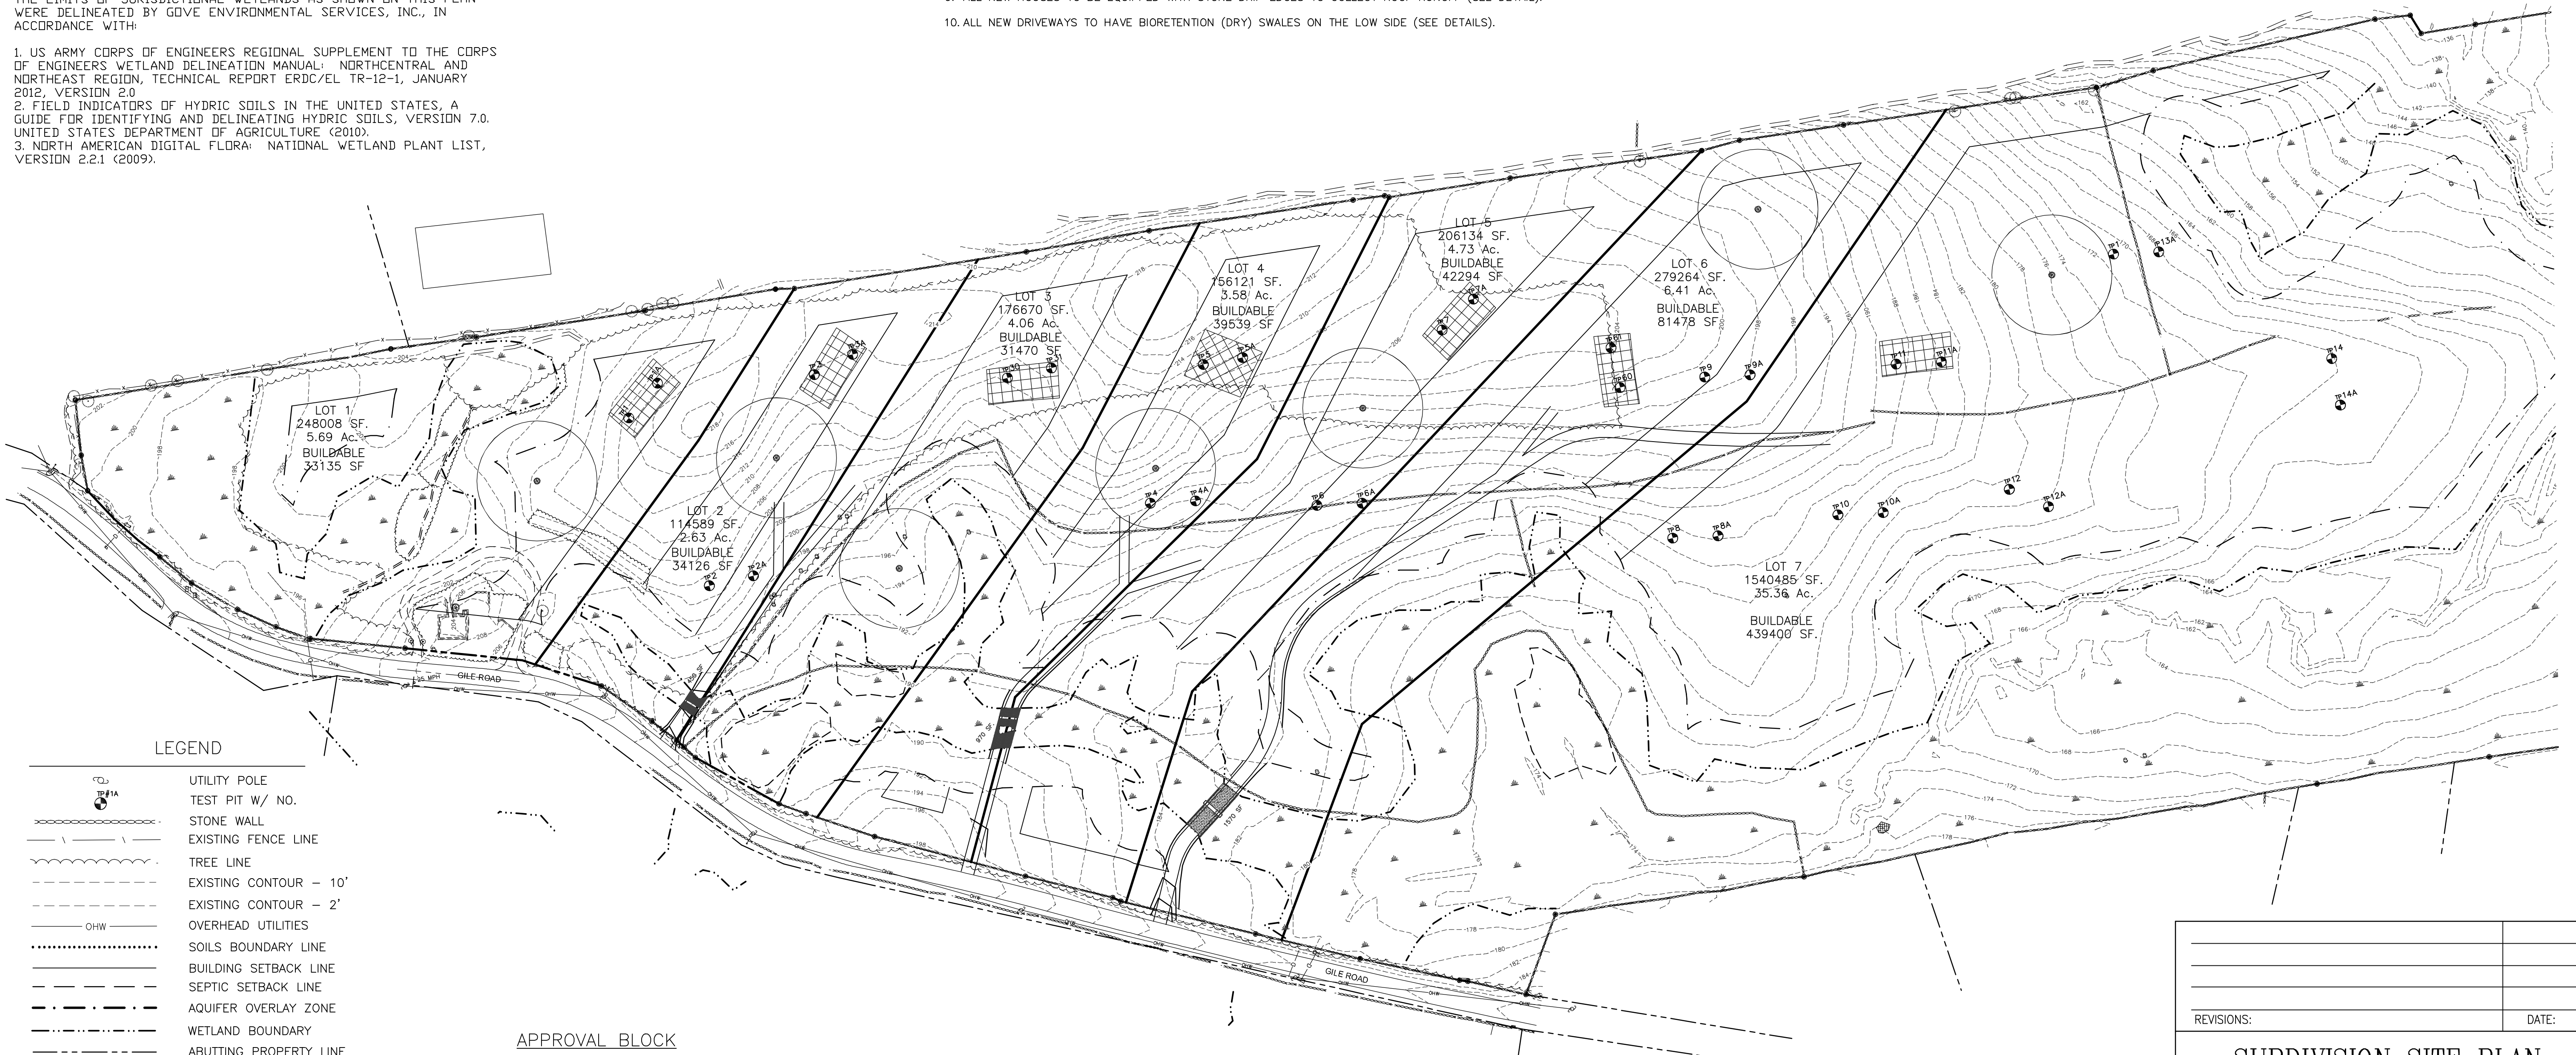
LEACH FIELD SETBACKS
POORLY DRAINED SOILS 75'
VERY POORLY DRAINED SOILS 75'

PREPARED FOR:

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LEGEND

- UTILITY POLE
- TEST PIT W/ NO.
- STONE WALL
- EXISTING FENCE LINE
- TREE LINE
- EXISTING CONTOUR - 10'
- EXISTING CONTOUR - 2'
- OHW
- OVERHEAD UTILITIES
- SOILS BOUNDARY LINE
- BUILDING SETBACK LINE
- SEPTIC SETBACK LINE
- AQUIFER OVERLAY ZONE
- WETLAND BOUNDARY
- ABUTTING PROPERTY LINE
- EXISTING PROPERTY LINE
- PROPOSED PROPERTY LINE
- 4000 SF SEPTIC RESERVE AREA
- PROP. WELL W/ 75' PROTECTIVE RAD.

APPROVAL BLOCK

APPROVED TOWN OF NOTTINGHAM PLANNING BOARD	
CHAIRPERSON	DATE

REVISIONS: _____ DATE: _____

SUBDIVISION SITE PLAN

FOR:
RESIDENTIAL DEVELOPMENT
GILE RD
NOTTINGHAM, NH

DATE: NOV. 2020 SCALE: 1"=60'
PROJ. NO: NH-1155 SHEET NO. 3 OF 3

